


UD2466 GRANNY FLAT - DA APPLICATION

84 LANCASTER AVENUE PUNCHBOWL 2196 | LOT 33 DP 11831 PREPARED FOR - JOSEPH MOKDASSI

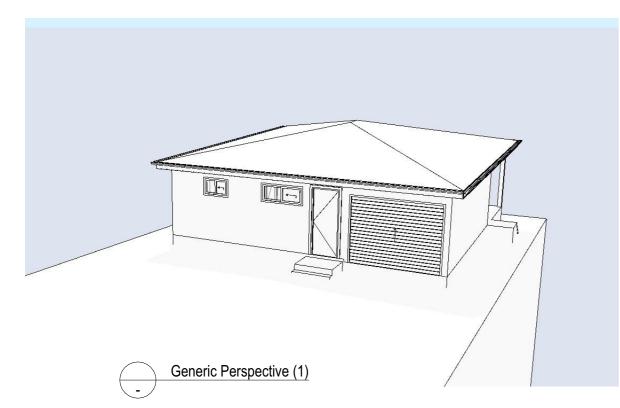

| Generic Perspective (2) |
|-------------------------|
| |

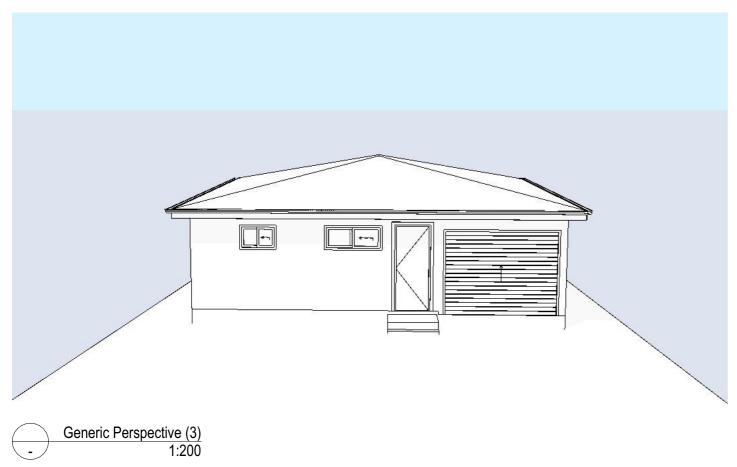

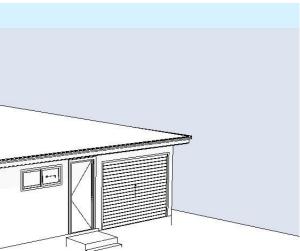




| CONTROLS | REQ'D | PROPOSED | COMPLIES |
|-------------------------------------------------------------------------------------------------------------------------------------------------------------------------------------|-------------------|---------------------|------------|
| LOT SIZE M ² | 450m ² | 935.8m ² | YES |
| SECONDARY DWELLING MAX FLOOR AREA | 60m ² | 60m ² | YES |
| MAXIMUM HEIGHT (as per DCP definition) The storey limit for attached secondary dwellings is 2 storeys | 2 | 1 | YES |
| MAX FLOOR SPACE RATIO | 0.5:1 | 0.35:1 | YES |
| SETBACKS FROM SIDE BOUNDARIES LHS RHS | 1.5m 1.5m | 1.51m 1.5m | YES YES |
| SETBACKS FROM REAR BOUNDARY | 1.5m | 1.52m | YES |
| LANDSCAPED AREA REQ'D M ² | N/A | 441m ² | YES |
| PRIVATE OPEN SPACE (as defined by Sepp) Secondary dwelling must not result in principal dwelling on site having less than the required landscaped area and private open space | | | YES |
| MAX ROOF PITCH | 35° | 15° | YES |

SITE PLAN LEGEND



| FLOOR AREA | |
|--------------------|-----------------------|
| ALFRESCO | 10.31 |
| GRANNY FLAT | 59.49 |
| GARAGE | 20.33 |
| PRINCIPLE DWELLING | 121.19 |
| | 211.32 m ² |

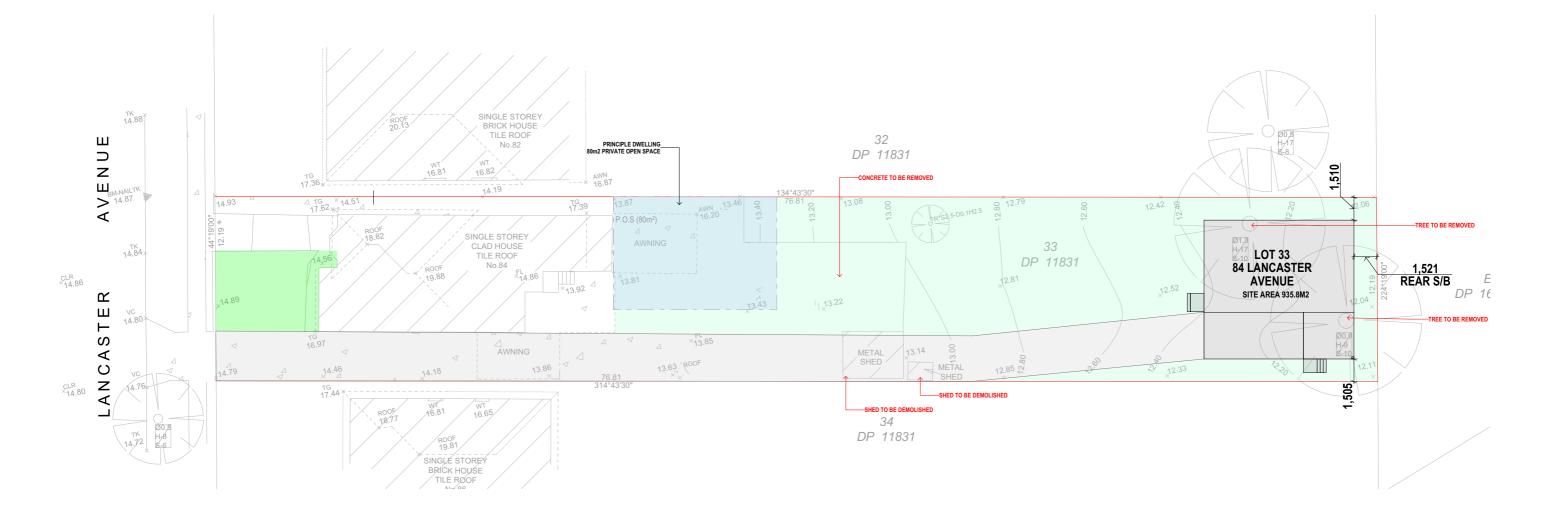

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Designer: Matthew Mina

matthew@universaldesigns.com.au

12 22/04/2025 11 30/03/2025 10 30/03/2025 21/03/2025 9 16/03/2025 8

TOWN PLANNER ROOF HEIGHT CLIENT CHANGES DA ISSUE CLIENT CHANGES CLIENT CHANGES

DRAWING : SITE PLAN

CLIENT

PROJECT :

JOSEPH MOKDASSI GRANNY FLAT LOT 33 DP 11831 84 LANCASTER AVENUE PUNCHBOWL 2196





JOB NO.

ISSUE

DATE 23/04/2025

UD2466

MM SCALE:


DRAWN BY:

1:250, 1:1

SHEETSIZE A3

APPLICATION : DA + CC

> SHEET NO: 1

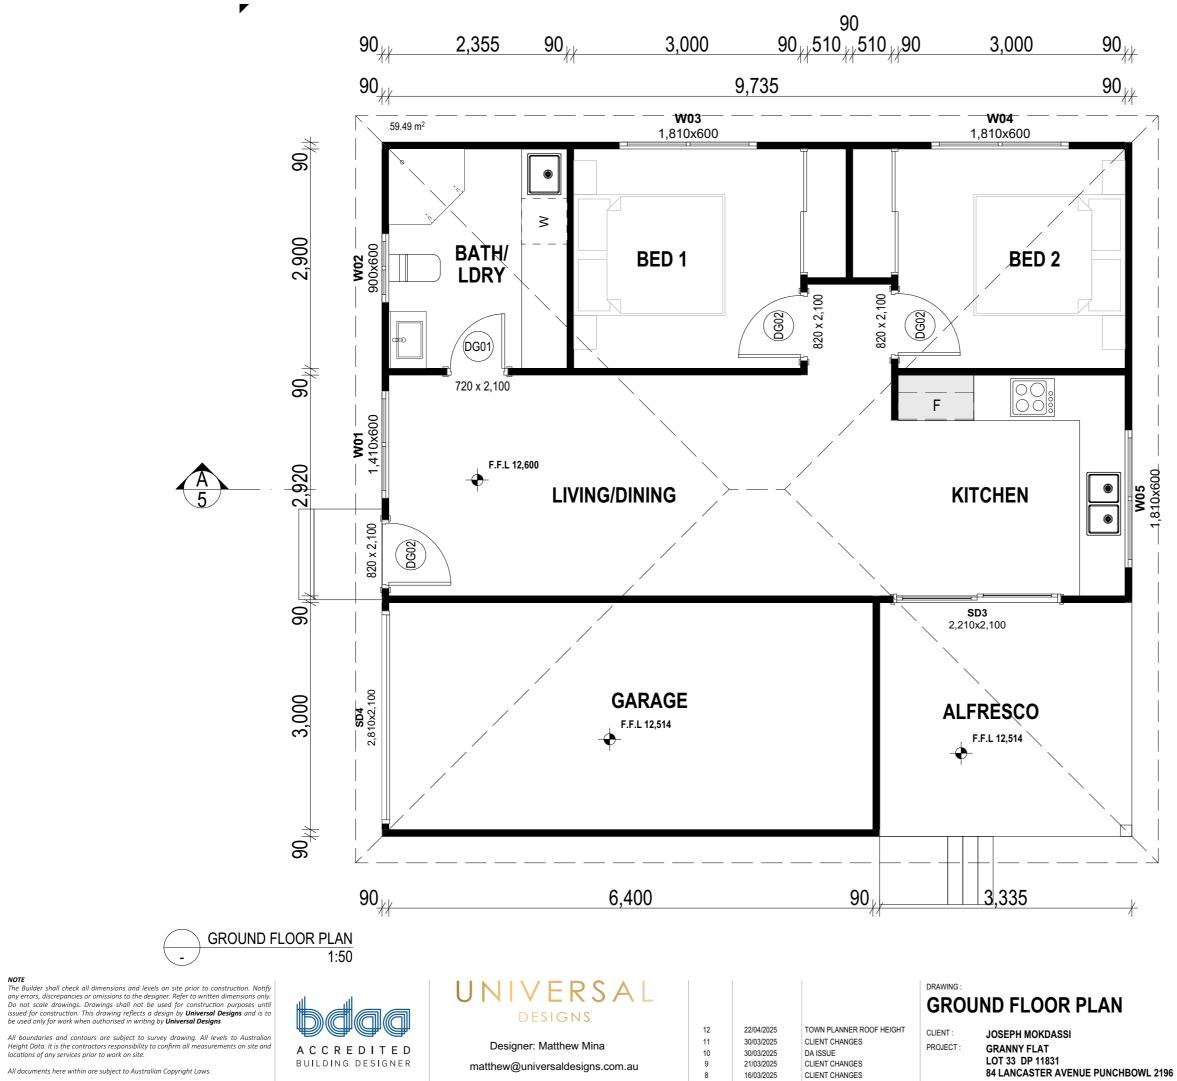

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| FL | OOR PLAN LEGEND |
|-----------------|------------------------------|
| ∎FW | FLOOR WASTE |
| ∭ MV | MECHANICAL VENTILATION |
| _@ SD | SMOKE DETECTOR / ALARM |
| оDЬ | DOWNPIPE |
| bDP+SP | DOWNPIPE + SPREADER |
| AC | AIR CONDITIONING DUCT |
| HWS | HOT WATER SYSTEM |
| WGxx | WINDOW NUMBER (GROUND FLOOR) |
| WFxx | WINDOW NUMBER (FIRST FLOOR) |
| DGxx | DOOR NUMBER (GROUND FLOOR) |
| DFxx | DOOR NUMBER (FIRST FLOOR) |
| EDxx | EXTERNAL DOOR NUMBER |
| | BULKHEAD |

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JOB NO.

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UD2466

DRAWN BY: MM

DATE 23/04/2025


APPLICATION : DA + CC


2

SCALE: 1:50 SHEETSIZE

A3

SHEET NO:

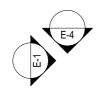

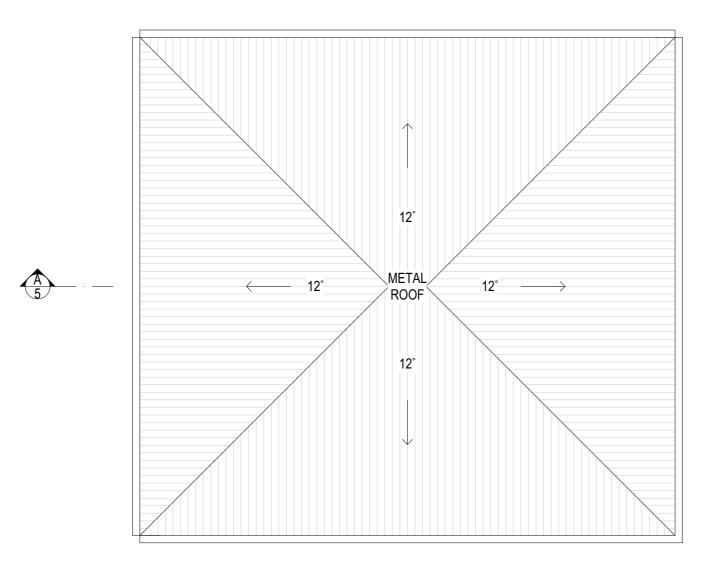

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16/03/2025

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TOWN PLANNER ROOF HEIGHT CLIENT CHANGES DA ISSUE CLIENT CHANGES CLIENT CHANGES

PROJECT :

JOSEPH MOKDASSI GRANNY FLAT LOT 33 DP 11831 84 LANCASTER AVENUE PUNCHBOWL 2196

22/04/2025 30/03/2025 30/03/2025 21/03/2025

| | TOTAL ROOF AREA |
|--------|-----------------------|
| PITCH | SURFACE AREA OF ROOF |
| 12.00° | 107.22 |
| | 107.22 m ² |





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DATE : 23/04/2025

APPLICATION : DA + CC


UD2466


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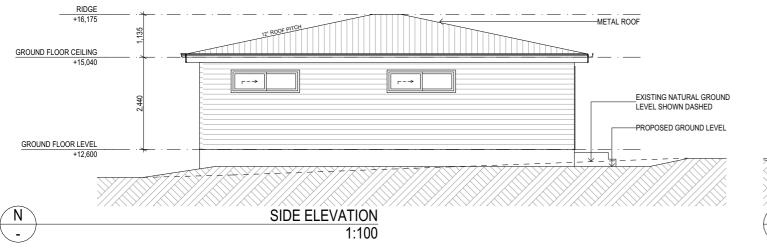
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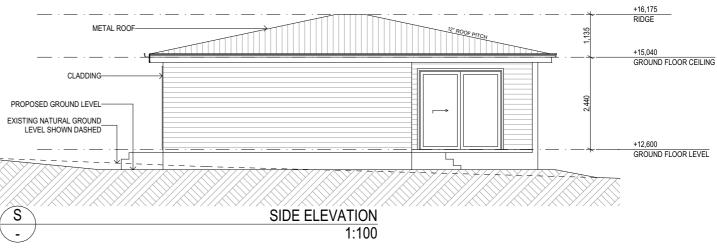
SHEET NO:

3





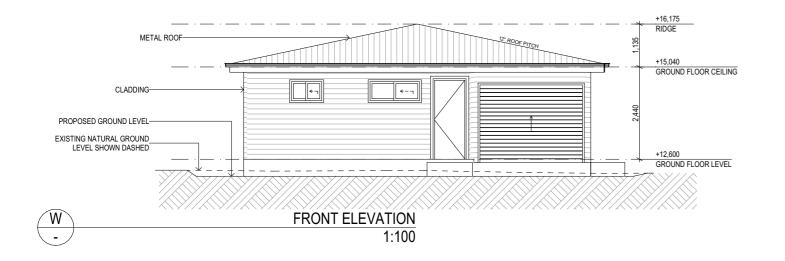

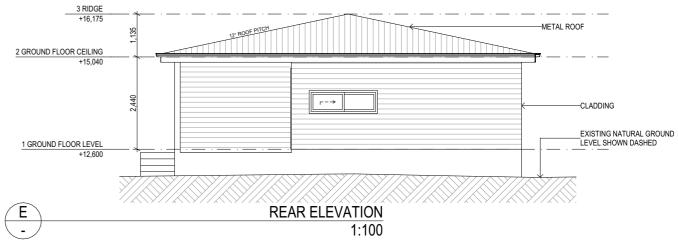

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12 22/04/2025 11 30/03/2025 10 30/03/2025 9

21/03/2025

16/03/2025

TOWN PLANNER ROOF HEIGHT CLIENT CHANGES DA ISSUE CLIENT CHANGES CLIENT CHANGES

CLIENT :

PROJECT :

DRAWING : **ELEVATIONS SHEET**

JOSEPH MOKDASSI GRANNY FLAT LOT 33 DP 11831 84 LANCASTER AVENUE PUNCHBOWL 2196

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DATE 23/04/2025 JOB NO.

ISSUE

UD2466


SCALE: 1:100

SHEETSIZE

A3

APPLICATION : DA + CC

> SHEET NO: 4

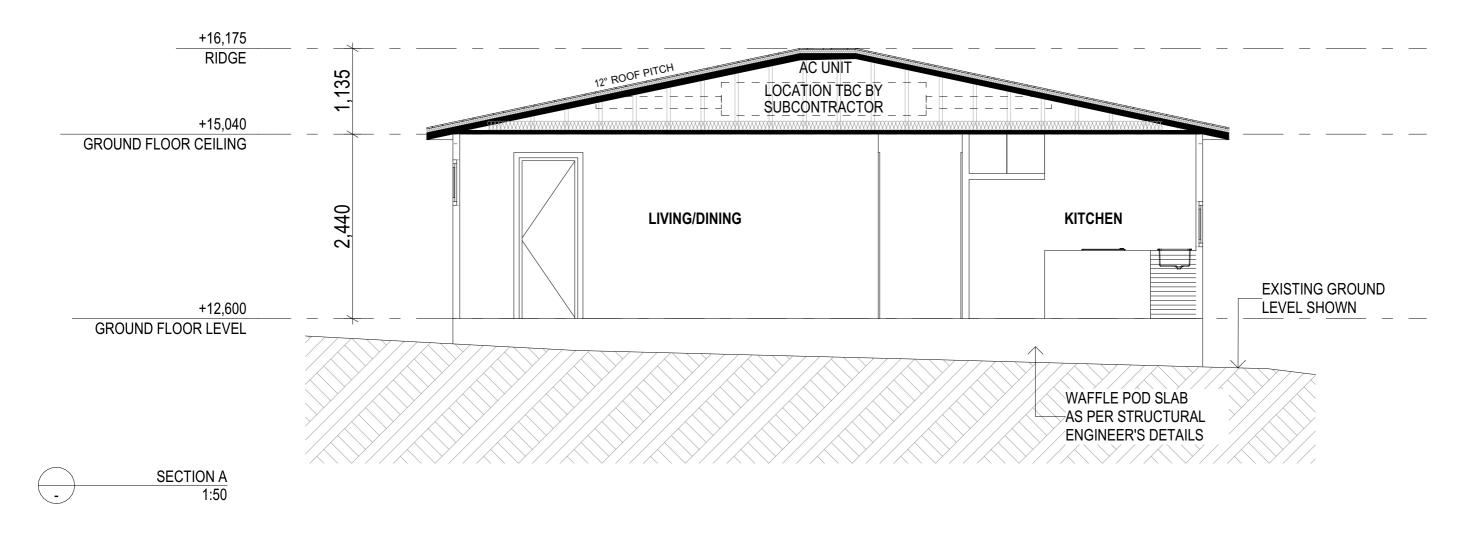

| | | WINDOW S | CHEDULE | | |
|-------------------------|---------------|---------------|---------------|---------------|---------------|
| ID | W01 | W02 | W03 | W04 | W05 |
| View from Opening Side | <u> </u> | 5 | | | |
| WxH | 1,410×600 | 900×600 | 1,810×600 | 1,810×600 | 1,810×600 |
| Quantity | 1 | 1 | 1 | 1 | 1 |
| Glass | Glass - Clear |
| W/D Nominal Sill Height | 1,500 | 1,500 | 1,500 | 1,500 | 950 |
| W/D Nominal Head Height | 2,100 | 2,100 | 2,100 | 2,100 | 1,550 |

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ACCREDITED BUILDING DESIGNER

UNIVERSAL DESIGNS

Designer: Matthew Mina

matthew@universaldesigns.com.au

TOWN PLANNER ROOF HEIGHT

CLIENT :

PROJECT :

DRAWING : **SECTION & WINDOW SCHEDULE**

JOSEPH MOKDASSI GRANNY FLAT LOT 33 DP 11831 84 LANCASTER AVENUE PUNCHBOWL 2196

22/04/2025 30/03/2025 30/03/2025 21/03/2025

DA ISSUE

CLIENT CHANGES CLIENT CHANGES

16/03/2025

CLIENT CHANGES



JOB NO.

ISSUE

UD2466

DRAWN BY: MM

SCALE: 1:50, 1:1

SHEETSIZE A3


APPLICATION : DA + CC

23/04/2025

DATE

SHEET NO: 5



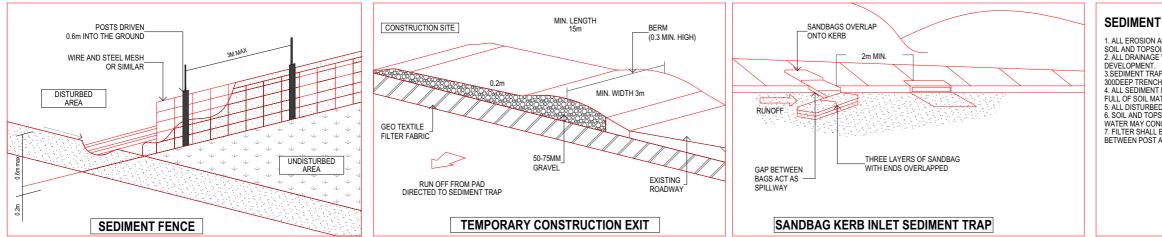

SEDIMENT O PO

SOIL EROSION NOTES

RETARD SEDIMENT LADEN RUNOFF.

NOTES

2 MINIMISE DISTURBED AREAS


SEDIMENT FENCE NOTES

TO BE ENTRENCHED 4. BACKFILL TRENCH OVER BASE OF FABRIC. BY GEOTEXTILE MANUFACTURER.



DRAWING SEDIMENT CONTROL PLAN

JOSEPH MOKDASSI GRANNY FLAT LOT 33 DP 11831 84 LANCASTER AVENUE PUNCHBOWL 2196

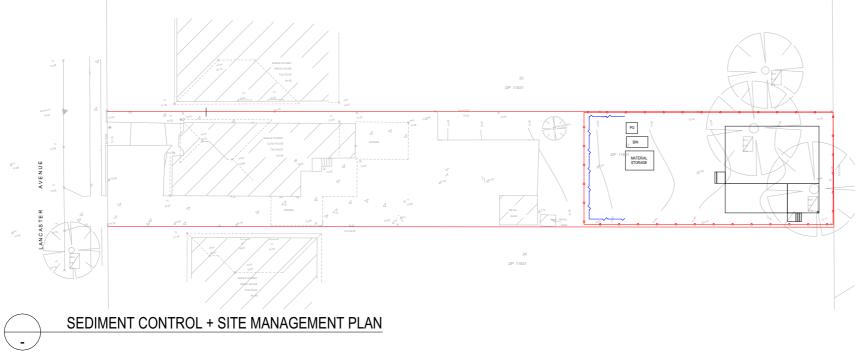

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ACCREDITED BUILDING DESIGNER

UNIVERSAL DESIGNS

Designer: Matthew Mina

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12 11 10

22/04/2025 30/03/2025 30/03/2025 21/03/2025 16/03/2025

TOWN PLANNER ROOF HEIGHT

CLIENT PROJECT

CLIENT CHANGES DA ISSUE CLIENT CHANGES CLIENT CHANGES

SEDIMENT CONTROL NOTES

1. ALL EROSION AND SEDIMENTATION CONTROL MEASURES, INCLUDING REVEGETATION AND STORAGE OF SOIL AND TOPSOIL, SHALL BE IMPLEMENTED TO THE STANDARDS OF THE SOIL CONSERVATION OF NSW. 2. ALL DRAINAGE WORKS SHALL BE CONSTRUCTED AND STABILIZED AS EARLY AS POSSIBLE DURING DUCLO DRAFT.

ALL DRAINAGE WORKS SHALL BE CONSTRUCTED AND STABILIZED AS EARLY AS POSSIBLE DURING DEVELOPMENT.
SEDIMENT TRAPS SHALL BE CONSTRUCTED AROUND ALL INLET PITS, CONSISTING OF 300MM WIDE x 300DEEP TRENCH.
ALL SEDIMENT BASINS AND TRAPS SHALL BE CLEANED WHEN THE STRUCTURES AREA MAXIMUM OF 60% FULL OF SOIL MATERIALS, INCLUDING THE MAINTENANCE PERIOD.
ALL DISTURBED AREAS SHALL BE REVEGITATED AS SOON AS THE RELEVANT WORKS ARE COMPLETED.
SOIL AND TOPSOIL STOCKPILES SHALL BE LOCATED AWAY FROM DRAINAGE LINES AND AREA WHERE WATER MAY CONCENTRATE.
FILTER SHALL BE CONSTRUCTED BY STRETCHING A FILTER FABRIC/PROPEX OR APPROVED EQUIVALENT DETWIED DOTAT 2 AO: CENTRES CADING A GRADING A FILTER FABRIC/PROPEX OR APPROVED EQUIVALENT

BETWEEN POST AT 3.0m CENTRES. FABRIC SHALL BE BURIED 150MM ALONG ITS LOWER

| CONTROL PLAN LEGEND | | | |
|---------------------|----------------|--|--|
| 0 | SITE FENCE | | |
| | SEDIMENT FENCE | | |

PORTALOO

1. TOPSOIL SHALL BE STRIPPED AND STOCKPILED OUTSIDE HAZARD AREAS SUCH AS DRAINAGE LINES. THIS TOPSOIL IS TO BE RE-SPREAD LATER ON AREAS TO BE REVEGETATED AND STABILISED ONLY. (i.e ALL FOOT-PATHS, BATTERS, SITE, REGRADING AREAS, DRAINAGE RESERVES AND CHANNELS). 2. TOP SOIL SHALL NOT BE SPREAD ON ANY OTHER AREAS SPECIFICALLY INSTRUCTED BY THE SUPERINTENDENT. IF

THEY ARE TO REMAIN FOR LONGER THAN ONE MONTH STOCKPILES SHALL BE PROTECTED FROM FROSION BY COVERING THEM WITH A MULCH AND HYDROSEEDING AND, IF NECESSARY, BY LOCATING BANKS OR DRAINS UPSLOPE TO DIVERT THE RUNOFF AROUND THEM.

IN SOME CIRCUMSTANCES IT MAY BE NECESSARY TO PLACE BANKS OR DRAINSDOWN STREAM OF A STOCKPILE TO

3. THE CONTRACTOR SHALL REGULARLY MAINTAIN ALL SEDIMENT AND EROSION CONTROL DEVICES AND REMOVE ACCUMULATED SILT FROM SUCH DEVICES BEFORE NO MORE THAN 60% OF THEIR CAPACITY IS LOST. A ALL THE SILT REMOVED SHALL BE DISPOSED OF AS DIRECTED BY THE SUPERINTENDENT. (NO SILT SHALL BE PLACED OUTSIDE THE LIMITS OF WORKS). THE PERIOD FOR MAINTAINING THESE DEVICES SHALL BE AT LEAST UNTIL ALL

DISTURBED AREAS ARE REVEGETATED AND FURTHER AS MAY BE DIRECTED BY THE SUPERINTENDENT OR COUNCIL

1. ALL EROSION AND SEDIMENT CONTROL MEASURES TO BE INSPECTED AND MAINTAINED DAILY BY CONTRACTOR / SITE MANAGER.

ALL STOCKPILES TO BE CLEARED FROM DRAINS, GUTTERS AND FOOTPATHS.
DRAINAGE IS TO BE CONNECTED TO STORMWATER SYSTEM AS SOON AS POSSIBLE.

5. ROADS AND FOOTPATH TO BE SWEPT DAILY 6. UNDER SECTION 16 OF THE CLEAN WATERS ACT, HEAVY FINES, INCLUDING A \$600 ON THE SPOT FINE, MAY BE IMPOSED IF A PERSON ALLOWS SOIL, CEMENT SLURRY OR OTHER BUILDING MATERIALS TO BE PUMPED, DRAINED OR ALLOWED TO ENTER THE STORMWATER SYSTEM.

1. CONSTRUCT SEDIMENT FENCE AS CLOSE AS POSSIBLE AND PARALLEL TO THE CONTOURS OF THE SITE. 2. DRIVE 15M LONG STAR PICKETS INTO GROUND MAX. 3M CTRS. 3. DIG A 150MM DEEP TRENCH ALONG THE UPSLOPE LINE OF THE FENCE FOR THE BOTTOM OF THE FABRIC

5. FIX SELF SUPPORTING GEOTEXTILE TO UPSLOPE SIDE OF POSTS WITH WIRE TIES OR AS RECOMMENDED

JOIN SECTIONS OF FABRIC AT A SUPPORT POST WITH A MIN. LAP OF 150MM.



JOB NO.

UD2466

DRAWN BY: MM

DATE 23/04/2025

12


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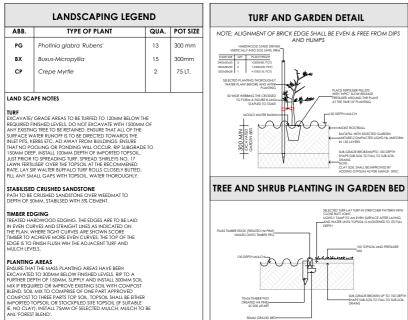
A3


APPLICATION DA + CC

> SHEET NO: 6

ISSUE



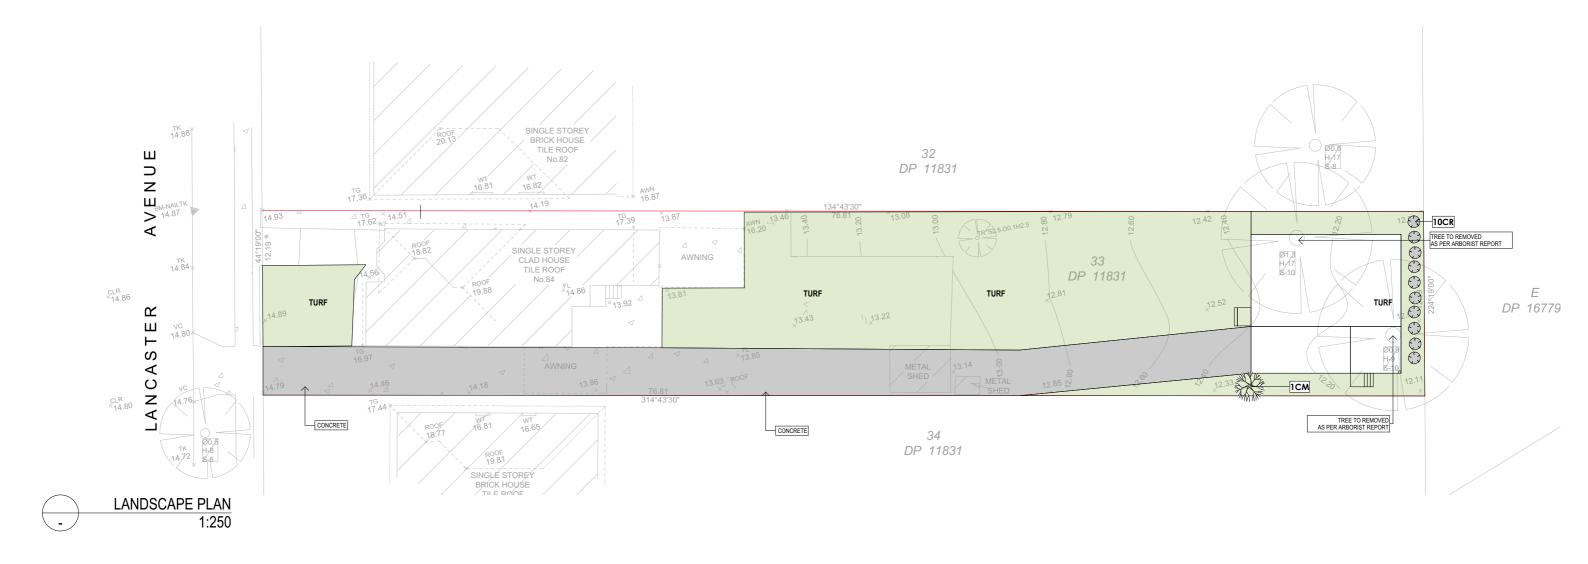

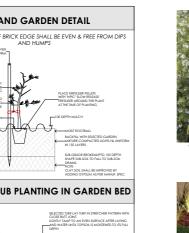

ACCREDITED

BUILDING DESIGNER



WESTRINGIA FRUTICOSA COASTAL ROSEMARY (CR)



PAVING STONE WITH PEBBLES

UNIVERSAL DESIGNS



PAVING STONE WITH DICHONDRA

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22/04/2025

30/03/2025

30/03/2025

21/03/2025

16/03/2025



LAGERSTROEMIA INDICA "TUSCACORE" CREPE MYRTLE (CM)

TOWN PLANNER ROOF HEIGHT

CLIENT CHANGES

CLIENT CHANGES

CLIENT CHANGES

DA ISSUE

CLIENT :

PROJECT :



ZOYSIA NARA NATIVE TURF



JOSEPH MOKDASSI GRANNY FLAT LOT 33 DP 11831 84 LANCASTER AVENUE PUNCHBOWL 2196

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Designer: Matthew Mina matthew@universaldesigns.com.au





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DATE 23/04/2025 JOB NO.

ISSUE

UD2466


SCALE: 1:250


SHEETSIZE


A3

APPLICATION : DA + CC

> SHEET NO: 7

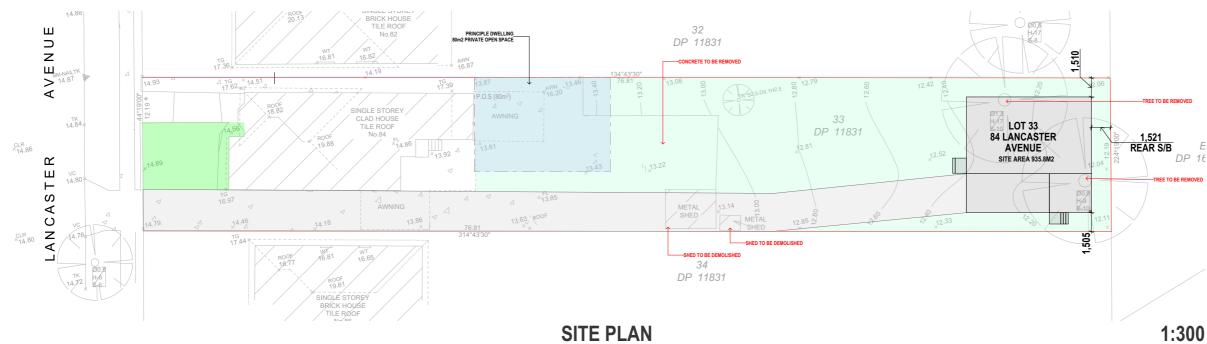

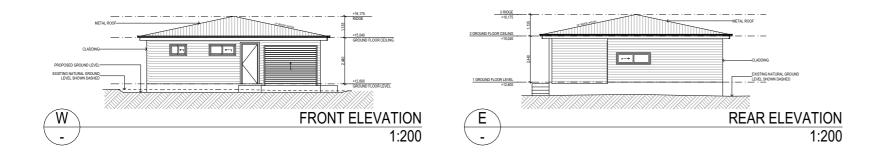

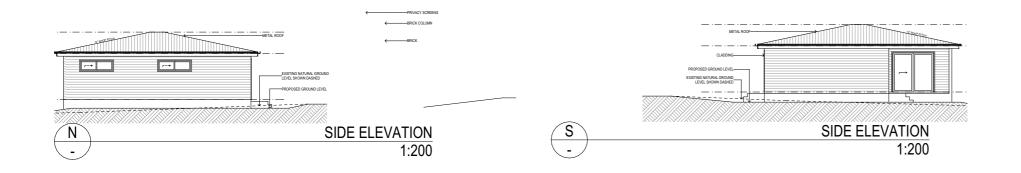

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ACCREDITED BUILDING DESIGNER

UNIVERSAL DESIGNS

Designer: Matthew Mina

matthew@universaldesigns.com.au

22/04/2025 30/03/2025 30/03/2025 21/03/2025 16/03/2025

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TOWN PLANNER ROOF HEIGHT CLIENT CHANGES DA ISSUE CLIENT CHANGES CLIENT CHANGES

CLIENT :

PROJECT :

DRAWING : **NOTIFICATION PLANS**

JOSEPH MOKDASSI GRANNY FLAT LOT 33 DP 11831 84 LANCASTER AVENUE PUNCHBOWL 2196

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DP 16



DRAWN BY: MM

SCALE: 1:300, 1:200

SHEETSIZE A3

APPLICATION : DA + CC

8

DATE

23/04/2025

SHEET NO:

UD2466

ISSUE

JOB NO.

ROOF

COLORBOND ROOF

MONUMENT

GUTTER

COLORBOND ROOF

MONUMENT


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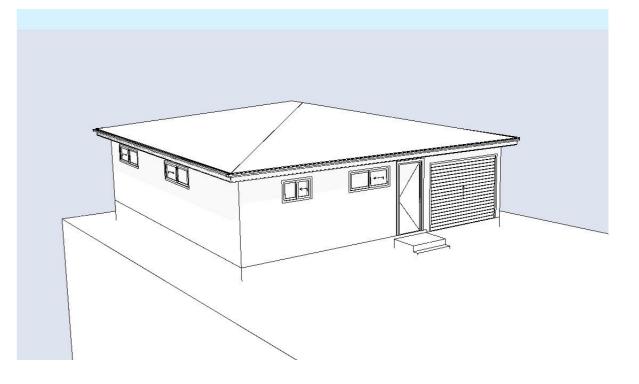
MONUMENT

GARAGE DOOR

PANEL LIFT MERBAU

| CLADDING |
|----------|
| MONUMENT |



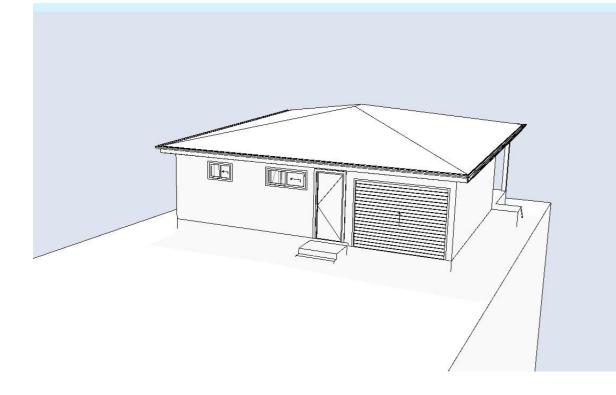

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16/03/2025

TOWN PLANNER ROOF HEIGHT CLIENT CHANGES DA ISSUE CLIENT CHANGES CLIENT CHANGES

CLIENT :

PROJECT :

DRAWING : **EXTERNAL FINISHES**

> JOSEPH MOKDASSI GRANNY FLAT LOT 33 DP 11831 84 LANCASTER AVENUE PUNCHBOWL 2196



DRAWN BY: MM

JOB NO.

ISSUE

UD2466

SCALE: 1:250

SHEETSIZE

A3

APPLICATION : DA + CC

DATE

23/04/2025

SHEET NO: 9